
PROPOSED "C-STORE & GAS STATION" LOCATED AT 4311 N TEXAS AVE, BRYAN, TX 77803

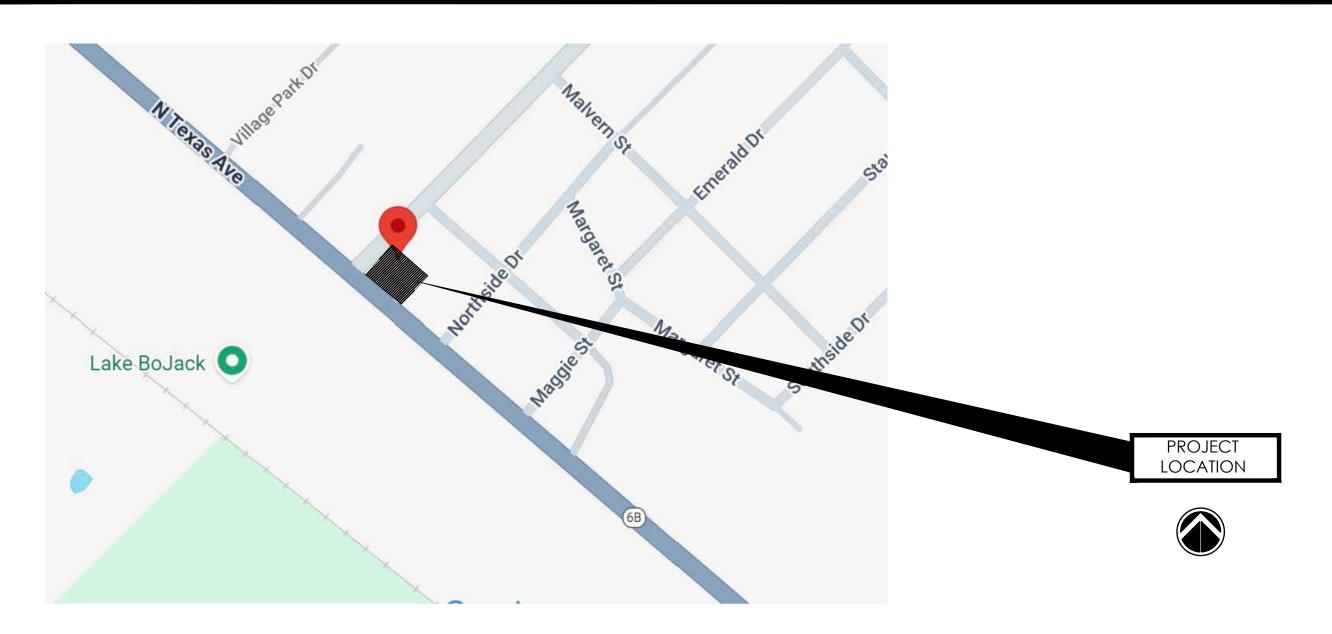

VICINITY MAP SCALE: N.T.S



PROJECT LOCATION SCALE: N.T.S

FLOOD PLAN INFORMATION

THE SUBJECTED PROPERTY " IS NOT " LOCATED IN FEDERAL INSURANCE ADMINISTRATION DESIGNATED FLOOD HAZARD AREA AND IS IN ZONE " X" MAP NO.48041C0185E.

DATED: 5/16/2012. THIS INFORMATION IS BASED ON GRAPHIC PLOTTING ONLY. WE DON'T ASSUME RESPONSIBILITY FOR EXACT DETERMINATION.

DEVELOPMENT AREA

TOTAL ACREAGE = 1.002 ACRES
PROPOSED DEVELOPMENT = 1.002 ACRES
TYPE OF DEVELOPMENT = 1STORY BUILDING

PROJECT DESCRIPTION

PROJECT NAME : PROPOSED "C-STORE AND GAS STATION"

LOCATION : 4311 N TEXAS AVE, BRYAN , TEXAS 77803

PROJECT DESCRIPTION : PROPOSED C-STORE 5,700 SQ.FT AND WASHATERIA AREA

OF 2,400 SQ.FT EACH.

SHEET INDEX


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C-0.0 COVER SHEET
C-1.0 DEMOLITION PLAN
C-2.0 SITE PLAN
C-3.0 GRADING PLAN
C-3.1 DRAINAGE PLAN
C-3.2 SITE SECTION
C-3.2 DRAINAGE CALCULATIONS-1
C-3.4 DRAINAGE CALCULATIONS-2
C-4.0 EROSION CONTROL PLAN
C-5.0 UTILITY PLAN

SITE DETAILS

CONSTRUCTION DETAILS

PROP - LAMPO'S GRO

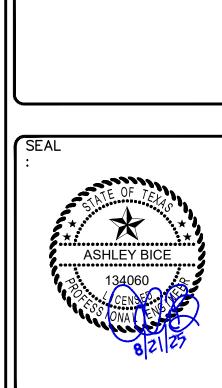

PROJECT NUMBER 22-000
SCALE

SCALE
DRAWN BY A:Z
CHECKED BY A.Z
SHEET TITLE :

COVER SHEET

DRAWING NUMBER:

MAKMO DESIGN - DESIGN WITH A DIFFERENT APPROACH —

ISSUE FOR:

FOR INTER REVIEW ONLY
BID ONLY
PERMITS SET
CONSTRUCTION SET

REVISIIONS:

NO. DATE DESCRIPTION


MAKMO DESIGN
86 ZENITH LANE, SUGAR LAND, TX 77498
PH # 832-231-7047 TBPE FIRM # 21236

LEGAL DESCRIPTION:
TOPOGRAPHY SURVEY OF LOTS 1, 2, 3, 6, 7, 8

MARGARET WALLACE SUBDIVISION
VOLUME 138, PAGE 573, B.C.P.R.
LOCATED IN THE MOSES BAINE LEAGUE, A-3,
BRAZOS COUNTY, TEXAS

1.072 ACRES (46,676.04 SQ. FT.)

PERTY OWNER CONTACT INFORMATION:
VNER NAME: NAZARANA PROPERTIES INC
PHONE: (979) 450-3350
EMAIL: asifumatiya@gmail.com

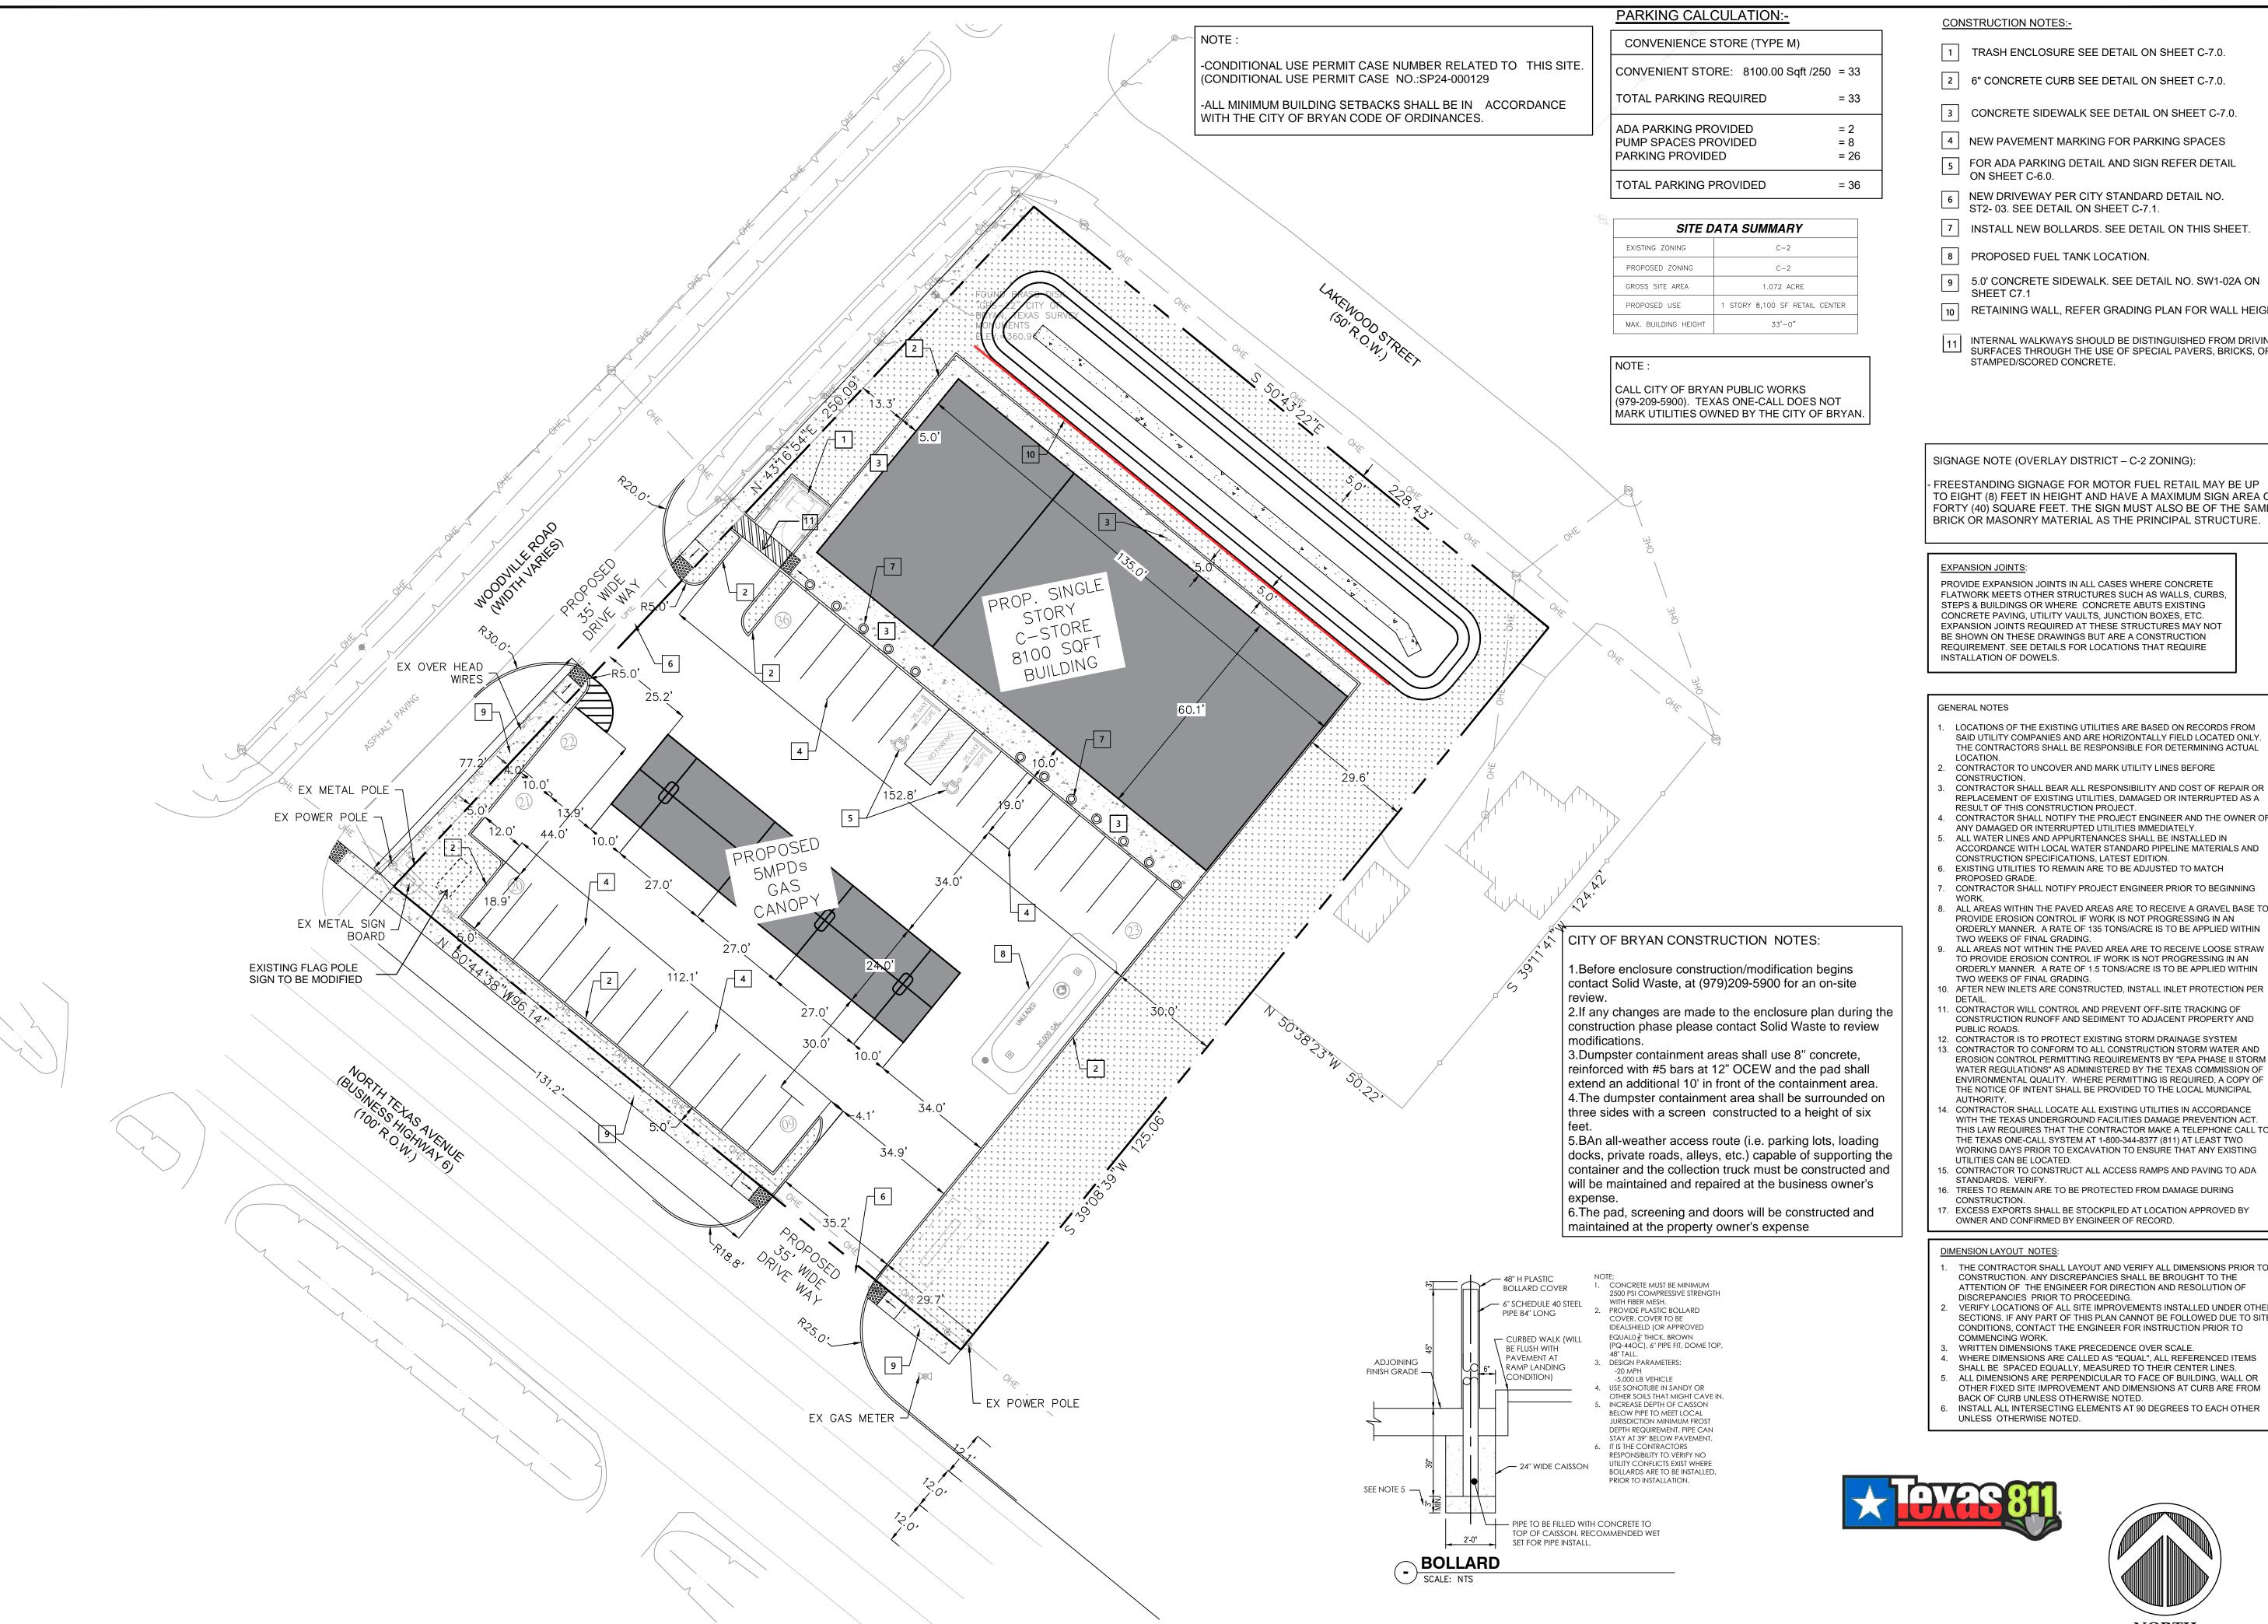

MAKMO DESIGN - DESIGN WITH A DIFFERENT APPROACH —

CONSTRUCTION NOTES:-

1 TRASH ENCLOSURE SEE DETAIL ON SHEET C-7.0.

2 6" CONCRETE CURB SEE DETAIL ON SHEET C-7.0.

3 CONCRETE SIDEWALK SEE DETAIL ON SHEET C-7.0.

4 NEW PAVEMENT MARKING FOR PARKING SPACES 5 FOR ADA PARKING DETAIL AND SIGN REFER DETAIL

→ ON SHEET C-6.0.

NEW DRIVEWAY PER CITY STANDARD DETAIL NO. ST2- 03. SEE DETAIL ON SHEET C-7.1.

7 INSTALL NEW BOLLARDS. SEE DETAIL ON THIS SHEET.

8 PROPOSED FUEL TANK LOCATION.

9 5.0' CONCRETE SIDEWALK. SEE DETAIL NO. SW1-02A ON

10 RETAINING WALL, REFER GRADING PLAN FOR WALL HEIGHT.

11 INTERNAL WALKWAYS SHOULD BE DISTINGUISHED FROM DRIVING SURFACES THROUGH THE USE OF SPECIAL PAVERS, BRICKS, OR STAMPED/SCORED CONCRETE.

SIGNAGE NOTE (OVERLAY DISTRICT - C-2 ZONING):

FREESTANDING SIGNAGE FOR MOTOR FUEL RETAIL MAY BE UP TO EIGHT (8) FEET IN HEIGHT AND HAVE A MAXIMUM SIGN AREA OF FORTY (40) SQUARE FEET. THE SIGN MUST ALSO BE OF THE SAME BRICK OR MASONRY MATERIAL AS THE PRINCIPAL STRUCTURE.


PROVIDE EXPANSION JOINTS IN ALL CASES WHERE CONCRETE FLATWORK MEETS OTHER STRUCTURES SUCH AS WALLS, CURBS, STEPS & BUILDINGS OR WHERE CONCRETE ABUTS EXISTING CONCRETE PAVING, UTILITY VAULTS, JUNCTION BOXES, ETC. EXPANSION JOINTS REQUIRED AT THESE STRUCTURES MAY NOT BE SHOWN ON THESE DRAWINGS BUT ARE A CONSTRUCTION REQUIREMENT. SEE DETAILS FOR LOCATIONS THAT REQUIRE INSTALLATION OF DOWELS.

- LOCATIONS OF THE EXISTING UTILITIES ARE BASED ON RECORDS FROM SAID UTILITY COMPANIES AND ARE HORIZONTALLY FIELD LOCATED ONLY. THE CONTRACTORS SHALL BE RESPONSIBLE FOR DETERMINING ACTUAL
- CONSTRUCTION
- CONTRACTOR SHALL BEAR ALL RESPONSIBILITY AND COST OF REPAIR OR REPLACEMENT OF EXISTING UTILITIES, DAMAGED OR INTERRUPTED AS A
- RESULT OF THIS CONSTRUCTION PROJECT. CONTRACTOR SHALL NOTIFY THE PROJECT ENGINEER AND THE OWNER OF ANY DAMAGED OR INTERRUPTED UTILITIES IMMEDIATELY.
- ACCORDANCE WITH LOCAL WATER STANDARD PIPELINE MATERIALS AND CONSTRUCTION SPECIFICATIONS, LATEST EDITION.
- EXISTING UTILITIES TO REMAIN ARE TO BE ADJUSTED TO MATCH PROPOSED GRADE.
- CONTRACTOR SHALL NOTIFY PROJECT ENGINEER PRIOR TO BEGINNING ALL AREAS WITHIN THE PAVED AREAS ARE TO RECEIVE A GRAVEL BASE TO
- PROVIDE EROSION CONTROL IF WORK IS NOT PROGRESSING IN AN ORDERLY MANNER. A RATE OF 135 TONS/ACRE IS TO BE APPLIED WITHIN TWO WEEKS OF FINAL GRADING. ALL AREAS NOT WITHIN THE PAVED AREA ARE TO RECEIVE LOOSE STRAW
- TO PROVIDE EROSION CONTROL IF WORK IS NOT PROGRESSING IN AN ORDERLY MANNER. A RATE OF 1.5 TONS/ACRE IS TO BE APPLIED WITHIN TWO WEEKS OF FINAL GRADING.
- 0. AFTER NEW INLETS ARE CONSTRUCTED, INSTALL INLET PROTECTION PER
- CONTRACTOR WILL CONTROL AND PREVENT OFF-SITE TRACKING OF CONSTRUCTION RUNOFF AND SEDIMENT TO ADJACENT PROPERTY AND
- 2. CONTRACTOR IS TO PROTECT EXISTING STORM DRAINAGE SYSTEM 13. CONTRACTOR TO CONFORM TO ALL CONSTRUCTION STORM WATER AND EROSION CONTROL PERMITTING REQUIREMENTS BY "EPA PHASE II STORM WATER REGULATIONS" AS ADMINISTERED BY THE TEXAS COMMISSION OF ENVIRONMENTAL QUALITY. WHERE PERMITTING IS REQUIRED, A COPY OF THE NOTICE OF INTENT SHALL BE PROVIDED TO THE LOCAL MUNICIPAL
- 4. CONTRACTOR SHALL LOCATE ALL EXISTING UTILITIES IN ACCORDANCE WITH THE TEXAS UNDERGROUND FACILITIES DAMAGE PREVENTION ACT. THIS LAW REQUIRES THAT THE CONTRACTOR MAKE A TELEPHONE CALL TO THE TEXAS ONE-CALL SYSTEM AT 1-800-344-8377 (811) AT LEAST TWO WORKING DAYS PRIOR TO EXCAVATION TO ENSURE THAT ANY EXISTING
- 5. CONTRACTOR TO CONSTRUCT ALL ACCESS RAMPS AND PAVING TO ADA STANDARDS. VERIFY.
- 6. TREES TO REMAIN ARE TO BE PROTECTED FROM DAMAGE DURING

OWNER AND CONFIRMED BY ENGINEER OF RECORD.

- . THE CONTRACTOR SHALL LAYOUT AND VERIFY ALL DIMENSIONS PRIOR TO CONSTRUCTION. ANY DISCREPANCIES SHALL BE BROUGHT TO THE ATTENTION OF THE ENGINEER FOR DIRECTION AND RESOLUTION OF DISCREPANCIES PRIOR TO PROCEEDING.
- VERIFY LOCATIONS OF ALL SITE IMPROVEMENTS INSTALLED UNDER OTHER SECTIONS. IF ANY PART OF THIS PLAN CANNOT BE FOLLOWED DUE TO SITE CONDITIONS, CONTACT THE ENGINEER FOR INSTRUCTION PRIOR TO
- COMMENCING WORK. WRITTEN DIMENSIONS TAKE PRECEDENCE OVER SCALE.
- WHERE DIMENSIONS ARE CALLED AS "EQUAL", ALL REFERENCED ITEMS SHALL BE SPACED EQUALLY, MEASURED TO THEIR CENTER LINES. ALL DIMENSIONS ARE PERPENDICULAR TO FACE OF BUILDING, WALL OR
- BACK OF CURB UNLESS OTHERWISE NOTED. INSTALL ALL INTERSECTING ELEMENTS AT 90 DEGREES TO EACH OTHER UNLESS OTHERWISE NOTED.



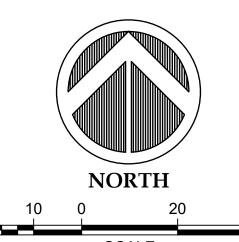

PH # 832-231-7047 TBPE FIRM # 21236 LEGAL DESCRIPTION: OPOGRAPHY SURVEY OF LOTS 1, 2, 3, 6, 7, 8 BLOCK 1 MARGARET WALLACE SUBDIVISION

DESCRIPTION

ISSUE FOR:

BID ONLY

PERMITS SET

REVISIIONS:

FOR INTER REVIEW ONLY

CONSTRUCTION SET

BRAZOS COUNTY, TEXAS LOT AREA:

VOLUME 138, PAGE 573, B.C.P.R.

OCATED IN THE MOSES BAINE LEAGUE, A-3

1.072 ACRES (46,676.04 SQ. FT.)

PROPERTY OWNER CONTACT INFORMATION DWNER NAME: NAZARANA PROPERTIES INC

PHONE: (979) 450-3350 EMAIL: asifumatiya@gmail.com

80 AMI LOCA AVE

DATE: 7/30/25 PROJECT NUMBER 22-000 SCALE DRAWN BY

A.Z


SITE PLAN

DRAWING NUMBER:

CHECKED BY

SHEET TITLE :

C-2.0

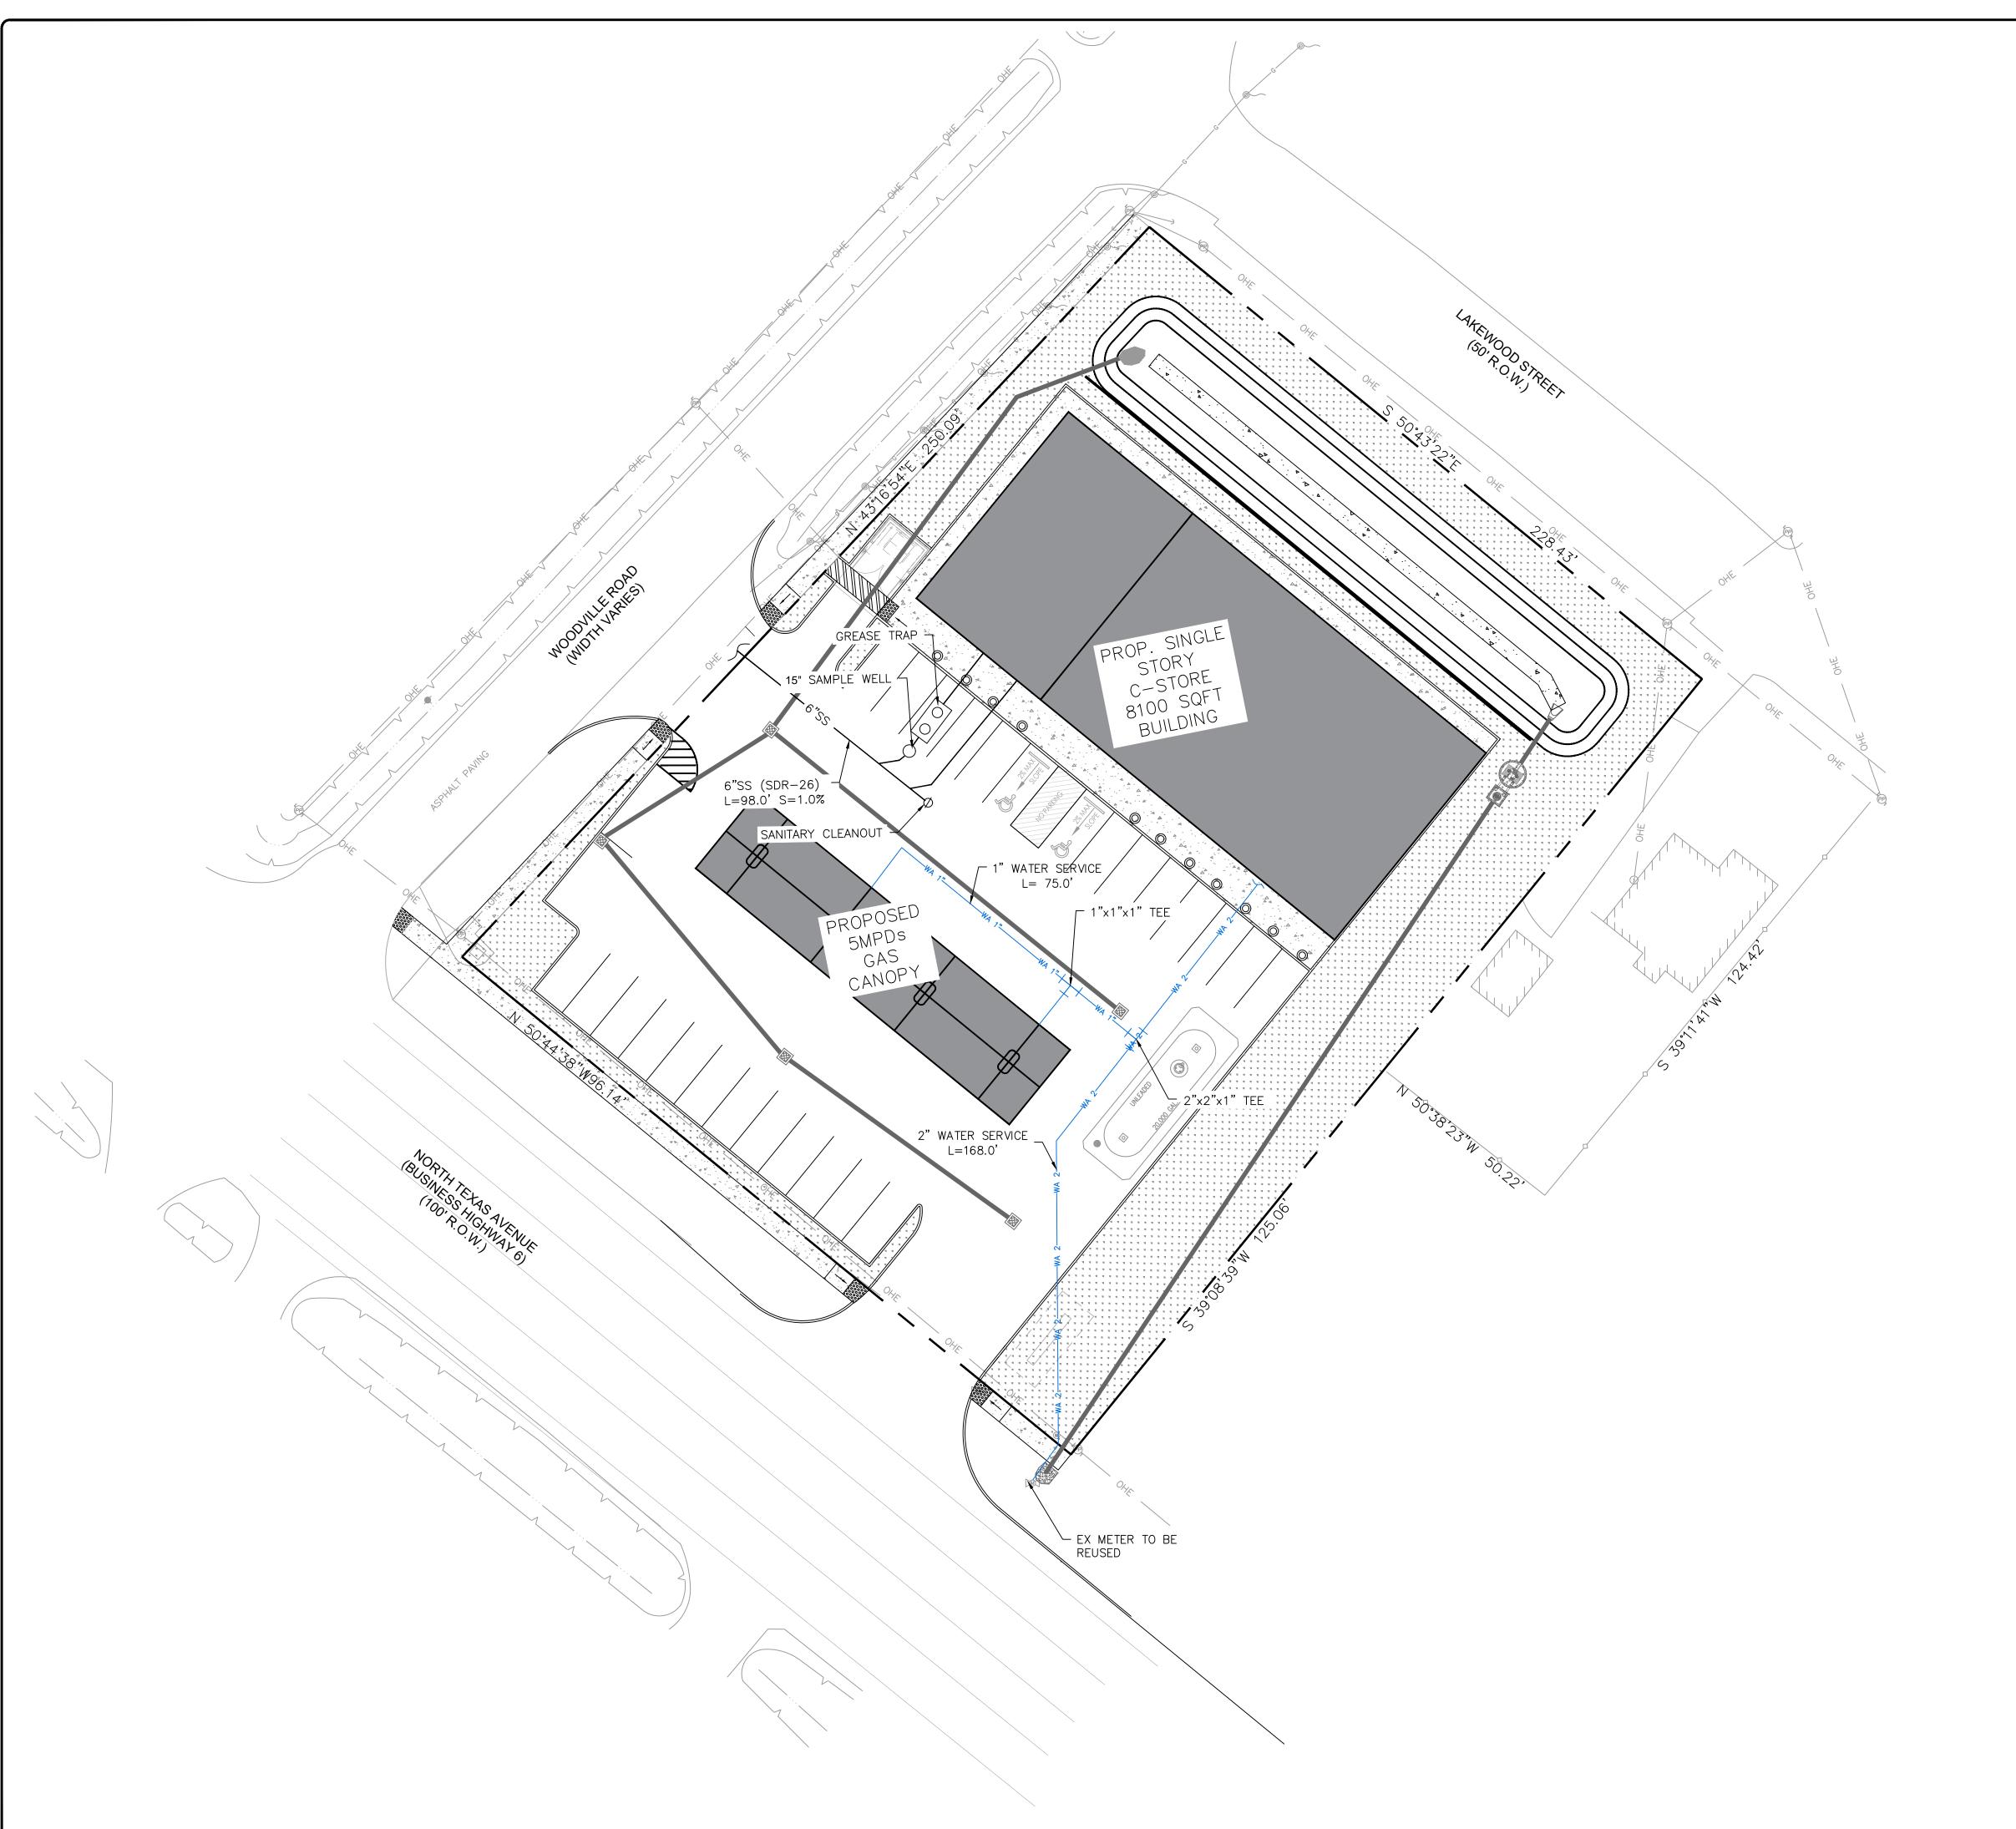

SEWER NOTES:

- SANITARY SEWER PIPE TO BE SCH. 40 (PVC) FOR 6" OR LESS AND SDR-35 (PVC) FOR 8" MEETING ASTM SPECIFICATIONS D1785 & D2665 UNLESS OTHERWISE NOTED.
- ALL SEWERS SHALL HAVE CLASS A BEDDING IN ACCORDANCE WITH BRYAN
- ALL SANITARY SEWERS CROSSING ABOVE OR BELOW WATERLINES WITH 6 INCHES TO 9 FEET CLEARANCE SHALL HAVE A 20' JOINT OF 150 PSI AWWA C-900 SDR-18 P.V.C. SANITARY SEWER PIPE CENTERED ON WATERLINE,
- EXCEPT WHERE DUCTILE IRON PIPE IS USED. SANITARY SEWER MANHOLE RIMS OUTSIDE OF PROPOSED PAVING WILL BE SET 3"-6" ABOVE THE SURROUNDING LEVEL FINISHED GRADE AFTER PAVING

WITH SLOPED BACKFILL ADDED FOR STORM WATER DRAINAGE AWAY FROM

PRIVATE SANITARY SEWERS ARE TO BE PRIVATELY OWNED, OPERATED AND MAINTAINED BY SERVICED PROPERTY OWNER.

MANHOLE RIM.

- WATER MAINS/METER CONSTRUCTION SHALL BE IN ACCORDANCE WITH BRYAN CITY FOR WATER MAIN CONSTRUCTION AND MATERIALS AND SPECIFICATION FOR WATER TAPS AND SERVICE. LINES 3/4" THROUGH 2", AND FOR LARGE METERS AND SPRINKLER CONNECTIONS WITH LATEST ADDENDA AND AMENDMENTS THERETO.
- 11/2" THRU 3" WATER MAIN SHALL BE SCH. 40 PVC PIPE.
- ALL WATER MAINS SHALL HAVE 6" OF BANK SAND ENVELOPE AND SHALL BE BACKFILLED TO A MINIMUM COMPACTED DEPTH OF 6" OVER THE TOP OF THE PIPE TO PROVIDE A COMPACTED ENCASEMENT.
- CONTRACTOR SHALL PROVIDE FOR A MINIMUM HORIZONTAL CLEARANCE OF 9' (NINE FEET) AND MINIMUM 2' (TWO FEET) BETWEEN OUTSIDE OF WATERLINES AND OUTSIDE EDGE OF SANITARY SEWER MANHOLES OR
- CONTRACTOR SHALL PROVIDE ADEQUATE THRUST BLOCKING TO WITHSTAND TEST PRESSURE SPECIFIED IN SPECIFICATION FOR WATER MAIN CONSTRUCTION AND MATERIALS WITH LATEST ADDENDA AND AMENDMENTS
- ALL WATERLINES TO BE DISINFECTED IN CONFORMANCE WITH AWWA C-651
- BACKFLOW PREVENTION DEVICE MUST BE INSTALLED ON IRRIGATION WATER METER. CONTRACTOR SHALL INSTALL DEVICE APPROVED FOR USE BY BRYAN CITY.

UNDERGROUND FIRE LINES MUST BE SUBMITTED TO FIRE PROTECTION GROUP FOR REVIEW AND A NOTIFICATION OF CONSTRUCTION IN RIGHT OF WAY PERMIT WILL BE REQUIRED FOR THE PROPOSED WORK WITHIN HARRIS COUNTY RIGHT-OF-WAY.

GENERAL NOTES

- LOCATIONS OF THE EXISTING UTILITIES ARE BASED ON RECORDS FROM SAID UTILITY COMPANIES AND ARE HORIZONTALLY FIELD LOCATED ONLY. THE CONTRACTORS SHALL BE RESPONSIBLE FOR DETERMINING ACTUAL LOCATION.
- CONTRACTOR TO UNCOVER AND MARK UTILITY LINES BEFORE CONSTRUCTION.
- CONTRACTOR SHALL BEAR ALL RESPONSIBILITY AND COST OF REPAIR OR REPLACEMENT OF EXISTING UTILITIES, DAMAGED OR INTERRUPTED AS A RESULT OF THIS CONSTRUCTION PROJECT.
- CONTRACTOR SHALL NOTIFY THE PROJECT ENGINEER AND THE OWNER OF ANY DAMAGED OR INTERRUPTED UTILITIES IMMEDIATELY. ALL WATER LINES AND APPURTENANCES SHALL BE INSTALLED IN
- ACCORDANCE WITH LOCAL WATER STANDARD PIPELINE MATERIALS AND CONSTRUCTION SPECIFICATIONS, LATEST EDITION. EXISTING UTILITIES TO REMAIN ARE TO BE ADJUSTED TO MATCH PROPOSED
- CONTRACTOR SHALL NOTIFY PROJECT ENGINEER PRIOR TO BEGINNING
- ALL AREAS WITHIN THE PAVED AREAS ARE TO RECEIVE A GRAVEL BASE TO
- PROVIDE EROSION CONTROL IF WORK IS NOT PROGRESSING IN AN ORDERLY MANNER. A RATE OF 135 TONS/ACRE IS TO BE APPLIED WITHIN TWO WEEKS OF FINAL GRADING. ALL AREAS NOT WITHIN THE PAVED AREA ARE TO RECEIVE LOOSE STRAW TO PROVIDE EROSION CONTROL IF WORK IS NOT PROGRESSING IN AN
- ORDERLY MANNER. A RATE OF 1.5 TONS/ACRE IS TO BE APPLIED WITHIN TWO WEEKS OF FINAL GRADING. 0. AFTER NEW INLETS ARE CONSTRUCTED, INSTALL INLET PROTECTION PER
- 1. CONTRACTOR WILL CONTROL AND PREVENT OFF-SITE TRACKING OF
- CONSTRUCTION RUNOFF AND SEDIMENT TO ADJACENT PROPERTY AND PUBLIC ROADS. 2. CONTRACTOR IS TO PROTECT EXISTING STORM DRAINAGE SYSTEM
- 3. CONTRACTOR TO CONFORM TO ALL CONSTRUCTION STORM WATER AND EROSION CONTROL PERMITTING REQUIREMENTS BY "EPA PHASE II STORM WATER REGULATIONS" AS ADMINISTERED BY THE TEXAS COMMISSION OF ENVIRONMENTAL QUALITY WHERE PERMITTING IS REQUIRED A COPY OF THE NOTICE OF INTENT AND CONSTRUCTION SITE NOTICE(S) SHALL BE PROVIDED TO THE LOCAL MUNICIPAL AUTHORITY. CONTRACTOR SHALL POST THE CONSTRUCTION SITE NOTICE(S) IN ACCORDANCE WITH THE TEXAS COMMISSION ON ENVIRONMENTAL QUALITY REQUIREMENTS 4. CONTRACTOR SHALL LOCATE ALL EXISTING UTILITIES IN ACCORDANCE
- WITH THE TEXAS UNDERGROUND FACILITIES DAMAGE PREVENTION ACT. THIS LAW REQUIRES THAT THE CONTRACTOR MAKE A TELEPHONE CALL TO THE TEXAS ONE-CALL SYSTEM AT 1-800-344-8377 (811) AT LEAST TWO WORKING DAYS PRIOR TO EXCAVATION TO ENSURE THAT ANY EXISTING UTILITIES CAN BE LOCATED.
- 5. CONTRACTOR TO CONSTRUCT ALL ACCESS RAMPS AND PAVING TO ADA STANDARDS. VERIFY.
- 16. TREES TO REMAIN ARE TO BE PROTECTED FROM DAMAGE DURING
- CONSTRUCTION. 7. EXCESS EXPORTS SHALL BE STOCKPILED AT LOCATION APPROVED BY OWNER AND CONFIRMED BY ENGINEER OF RECORD.

BID ONLY

ISSUE FOR:

FOR INTER REVIEW ONLY PERMITS SET CONSTRUCTION SET

REVISIIONS: NO. DATE



LEGAL DESCRIPTION:

BLOCK 1 MARGARET WALLACE SUBDIVISION VOLUME 138, PAGE 573, B.C.P.R. LOCATED IN THE MOSES BAINE LEAGUE, A-3, BRAZOS COUNTY, TEXAS

OPOGRAPHY SURVEY OF LOTS 1, 2, 3, 6, 7, 8

LOT AREA: 1.072 ACRES (46,676.04 SQ. FT.)

PROPERTY OWNER CONTACT INFORMATION: DWNER NAME: NAZARANA PROPERTIES INC

PHONE: (979) 450-3350 EMAIL: asifumatiya@gmail.com

803

AMI LOCA AVE

DATE: 7/30/25 PROJECT NUMBER 22-000 SCALE DRAWN BY

> UTILITY **PLAN**

A.Z


DRAWING NUMBER:

CHECKED BY

SHEET TITLE :

C-5.0

MAKMO DESIGN - DESIGN WITH A DIFFERENT APPROACH

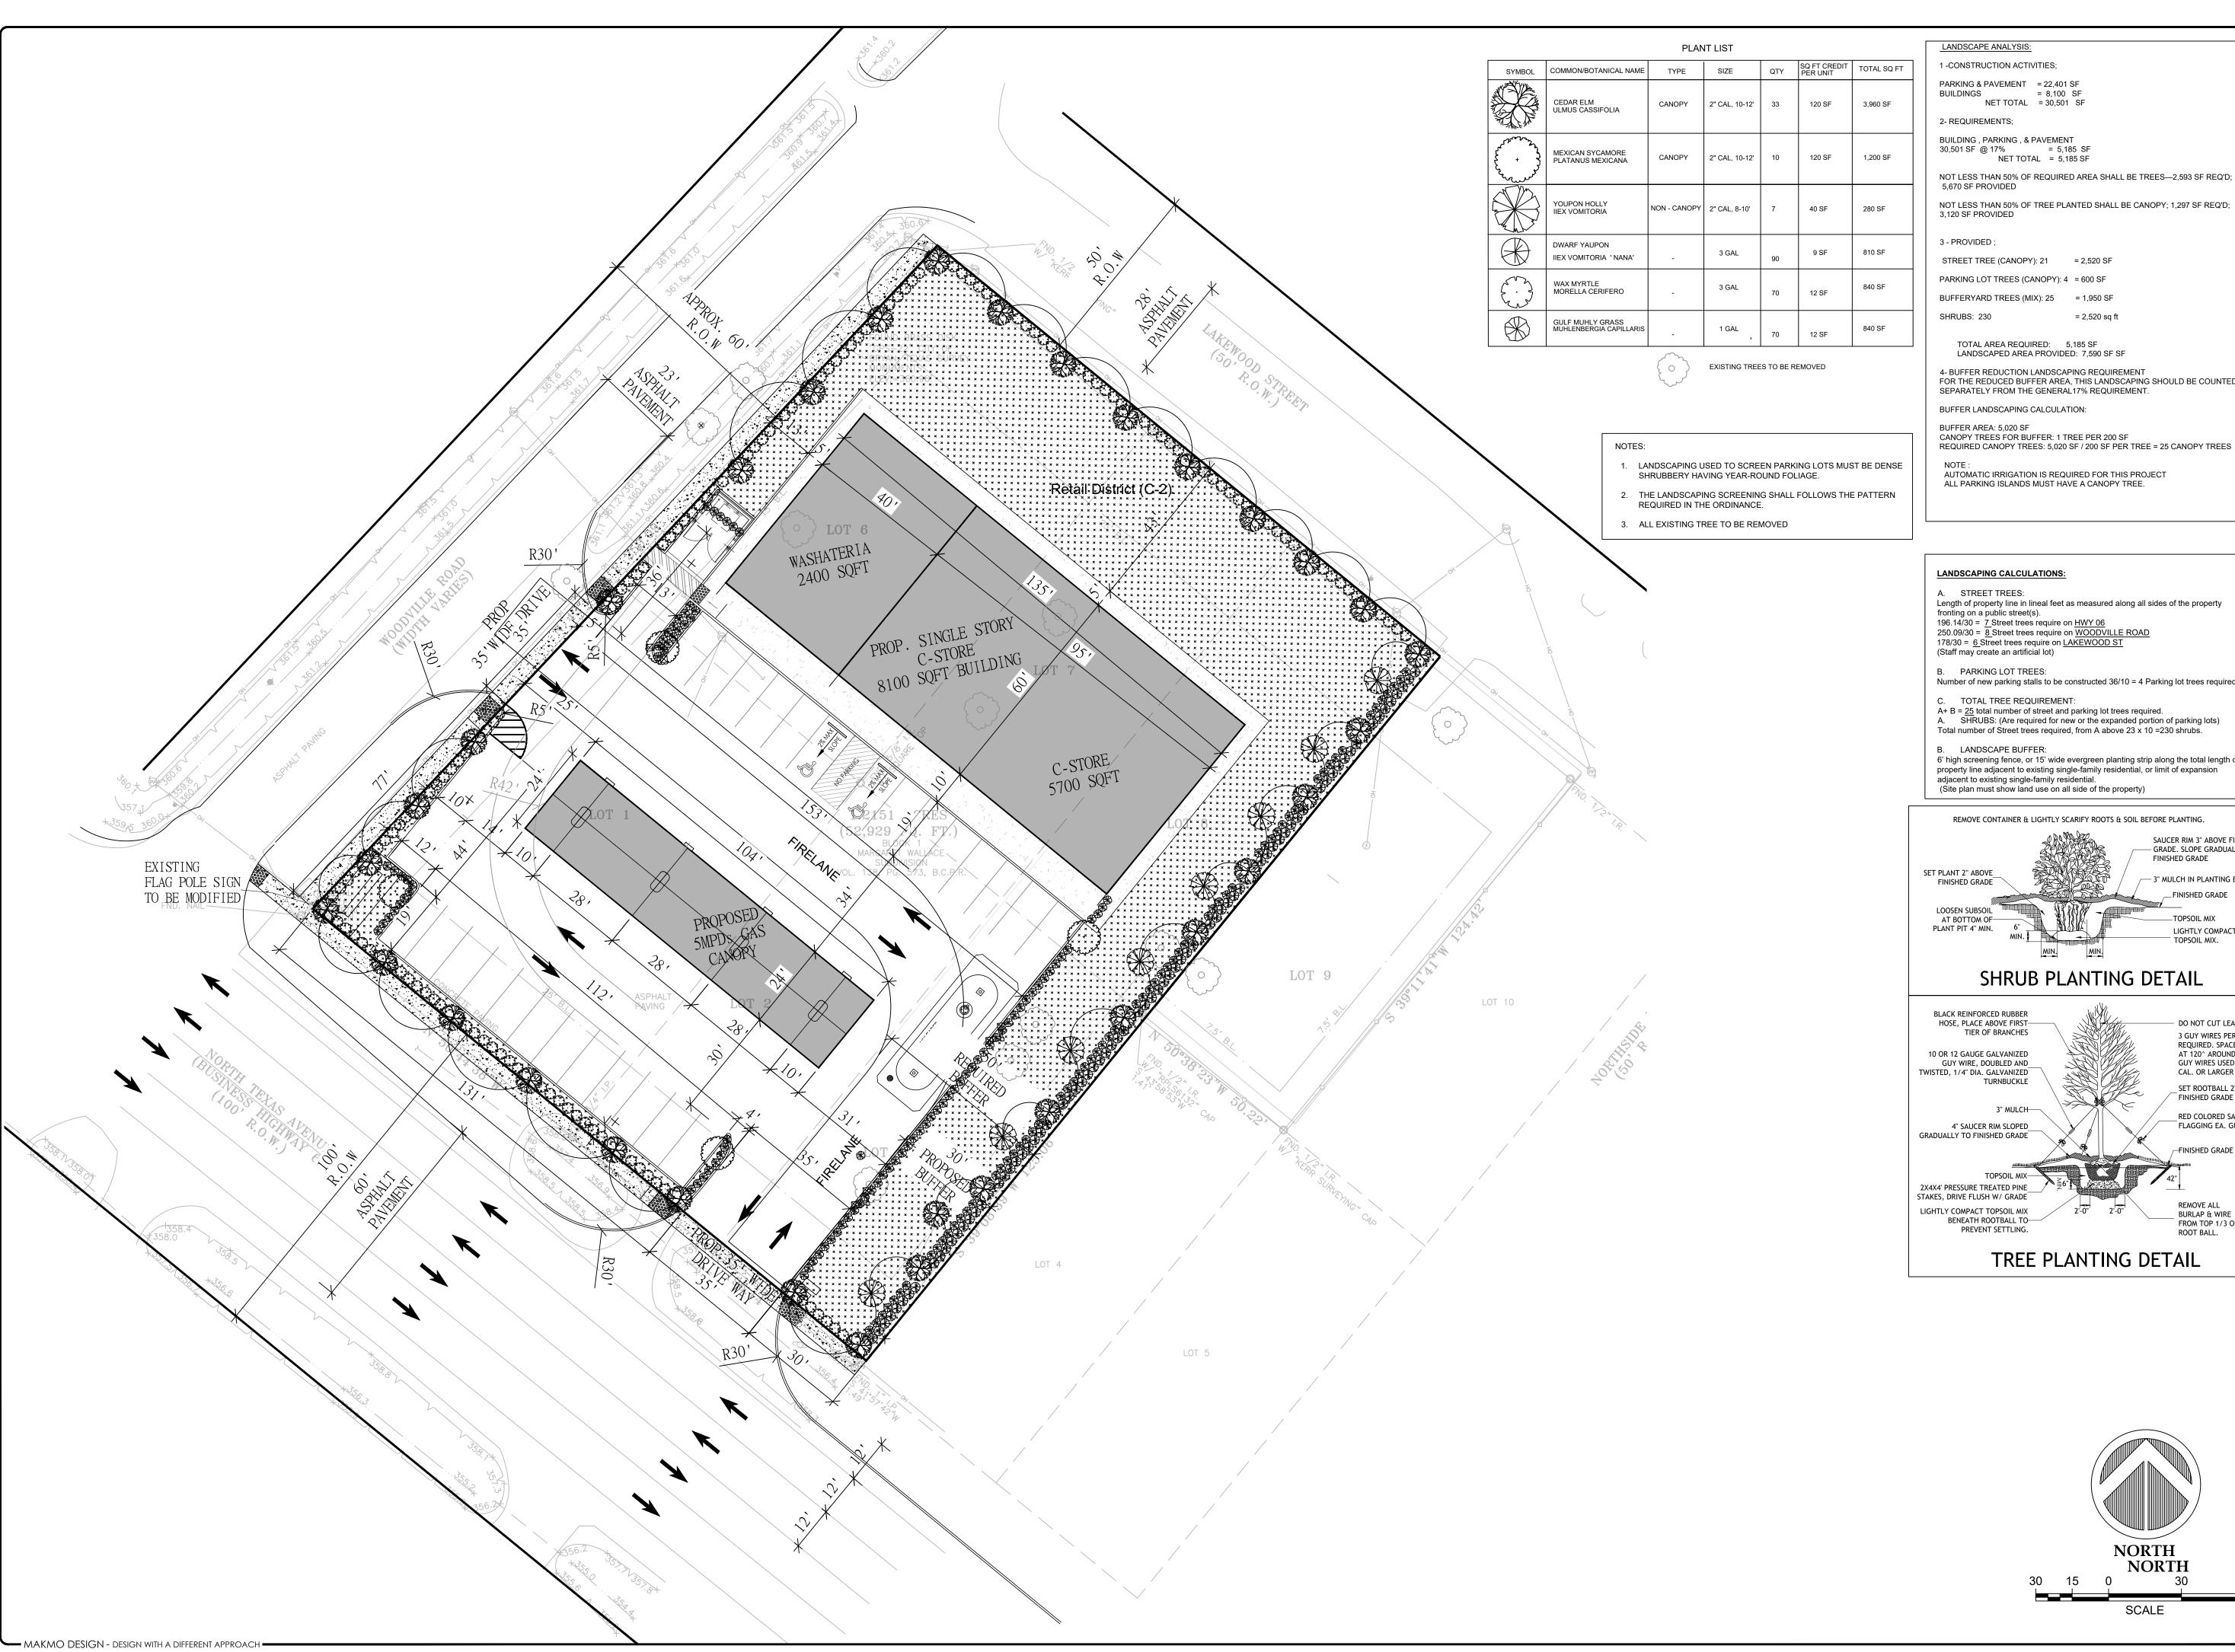

1 -CONSTRUCTION ACTIVITIES;

PARKING & PAVEMENT = 22,401 SF BUILDINGS = 8,100 SF

BUILDING , PARKING , & PAVEMENT 30,501 SF @ 17% = 5,185 SF NET TOTAL = 5,185 SF

NOT LESS THAN 50% OF REQUIRED AREA SHALL BE TREES—2,593 SF REQ'D;

NOT LESS THAN 50% OF TREE PLANTED SHALL BE CANOPY; 1,297 SF REQ'D;

STREET TREE (CANOPY): 21 = 2,520 SF PARKING LOT TREES (CANOPY): 4 = 600 SF BUFFERYARD TREES (MIX): 25 = 1,950 SF = 2,520 sq ft

TOTAL AREA REQUIRED: 5,185 SF LANDSCAPED AREA PROVIDED: 7,590 SF SF

4- BUFFER REDUCTION LANDSCAPING REQUIREMENT FOR THE REDUCED BUFFER AREA, THIS LANDSCAPING SHOULD BE COUNTED

BUFFER LANDSCAPING CALCULATION:

BUFFER AREA: 5,020 SF CANOPY TREES FOR BUFFER: 1 TREE PER 200 SF

AUTOMATIC IRRIGATION IS REQUIRED FOR THIS PROJECT

1.072 ACRES (46,676.04 SQ. FT.) ALL PARKING ISLANDS MUST HAVE A CANOPY TREE. OPERTY OWNER CONTACT INFORMATION

ISSUE FOR:

BID ONLY

PERMITS SET

REVISIIONS:

FOR INTER REVIEW ONLY

NO. DATE DESCRIPTION

PH # 832-231-7047 TBPE FIRM # 21236

LEGAL DESCRIPTION:

TOPOGRAPHY SURVEY OF LOTS 1, 2, 3, 6, 7, 8,

MARGARET WALLACE SUBDIVISION VOLUME 138, PAGE 573, B.C.P.R.

DCATED IN THE MOSES BAINE LEAGUE, A-3

BRAZOS COUNTY, TEXAS

dwner name: nazarana properties inc PHONE: (979) 450-3350

EMAIL: asifumatiya@gmail.com

GROCI

CONSTRUCTION SET

LANDSCAPING CALCULATIONS:

A. STREET TREES: Length of property line in lineal feet as measured along all sides of the property

fronting on a public street(s). 196.14/30 = 7 Street trees require on HWY 0 250.09/30 = 8 Street trees require on WOODVILLE ROAD

178/30 = 6 Street trees require on LAKEWOOD ST

(Staff may create an artificial lot)

Number of new parking stalls to be constructed 36/10 = 4 Parking lot trees required.

C. TOTAL TREE REQUIREMENT:

A+ B = <u>25</u> total number of street and parking lot trees required.


A. SHRUBS: (Are required for new or the expanded portion of parking lots) Total number of Street trees required, from A above 23 x 10 =230 shrubs.

6' high screening fence, or 15' wide evergreen planting strip along the total length of property line adjacent to existing single-family residential, or limit of expansion

adjacent to existing single-family residential. (Site plan must show land use on all side of the property)


REMOVE CONTAINER & LIGHTLY SCARIFY ROOTS & SOIL BEFORE PLANTING. SAUCER RIM 3" ABOVE FINISHED - GRADE. SLOPE GRADUALLY TO FINISHED GRADE — 3" MULCH IN PLANTING BED LIGHTLY COMPACTED

SHRUB PLANTING DETAIL

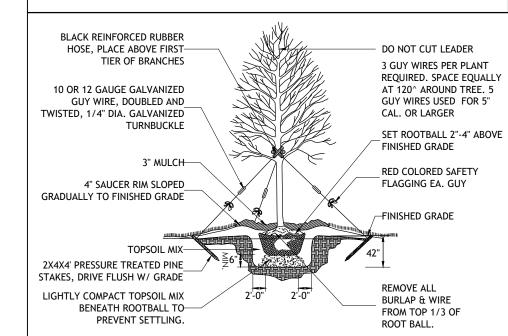

TREE PLANTING DETAIL

SCALE

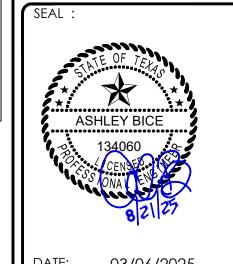

 \mathcal{S}

E:	03/0	03/06/2025		
IFCT NI	IMRER	•	25-0	

SCALE

DRAWN BY CHECKED BY A.Z SHEET TITLE

LANDSCAPING SITE PLAN

DRAWING NUMBER: L-100

